

**STATE OF HAWAII
DEPARTMENT OF TRANSPORTATION**

**ADDENDUM NO. 1
FOR
TEMPORARY KAPAA BYPASS ROAD REPAIR,
VICINITY OF OLOHENA ROAD
DISTRICTS OF KAWAIHAU
ISLAND OF KAUAI
PROJECT NO. 5600-02-23M
February 9, 2024**

This Addendum shall make the following amendments to the Bid Documents:

A. PLANS:

1. Delete Plan Sheet No. **8** – Water Pollution and Erosion Control Notes and replace with the attached Plan Sheet No. **ADD. 8** – WATER POLLUTION AND EROSION CONTROL NOTES
2. Delete Plan Sheet No. **14** – Roadway Plan and replace with the attached Plan Sheet No. **ADD. 14** – ROADWAY PLAN

The following are provided for information.

B. PRE-BID MEETING MINUTES

1. Attached are the January 25, 2024 Pre-Bid Meeting Minutes and Attendance Sheet for information.

C. RESPONSES TO REQUEST FOR INFORMATION (RFI'S / QUESTIONS)

1. The attached Responses to Request for Information is provided for information.

Please acknowledge receipt of this Addendum No. 1 by recording the date of its receipt in the space provided on page P-4 of the Proposal.



for LAWRENCE J. DILL
Program Manager

FED. ROAD DIST. NO.	STATE	PROJ. NO.	FISCAL YEAR	SHEET NO.	TOTAL SHEETS
HAWAII	HAW.	5600-02-23M	2024	ADD.8	21

WATER POLLUTION AND EROSION CONTROL NOTES (Cont.):

E. PERMIT REQUIREMENTS:

1. The calculated land disturbance area for this project based on the construction plans is 0.17 acres not including Contractor Staging and Storage areas. If the total of the disturbed area and the Contractor Staging and Storing is one acre or greater, the Contractor shall obtain the NPDES Construction Activities Permit using HDOT's latest SWPPP template. See Hawaii Administrative Rules Chapter 11-55, Appendix C for the definition of land disturbance. The Contractor shall be responsible for obtaining the required NPDES Construction Activities Permit and complying with the requirements of HAR 11-55 including, but not limited to:
 - a. Deadlines for initiating and completing initial stabilization
 - b. Increased inspection frequency and installation of rain gage if applicable
 - c. Deadlines to initiate and complete repairs to BMPs
 - d. Reporting requirements and corrective action reports
2. Comply with all applicable State and Federal Permit conditions. Permits may include, but not limited to:
 - a. NPDES Permit for Construction Activities
 - b. NPDES Permit for Construction Dewatering
 - c. NPDES Permit for Hydrotesting Waters
 - d. Water Quality Certification
 - e. Stream Channel Alteration Permit
 - f. Section 404 Army Corps of Engineer Permit

F. SITE-SPECIFIC BMP REQUIREMENTS:

Each BMP below is referenced to the corresponding section of the current HDOT Construction Best Management Practices Field Manual and appropriate Supplemental Sheets. The Manual may be obtained from the HDOT Statewide Stormwater Management Program Website at <http://www.stormwaterhawaii.com/resources/contractors-and-consultants/> under Construction Best Management Practices Field Manual. Supplemental BMP sheets are located at <http://www.stormwaterhawaii.com/resources/contractors-and-consultants/storm-water-pollution-prevention-plan-swPPP/> under Concrete Curing and Irrigation Water.


The requirements for Water Pollution, Dust, and Erosion Control submittals are included in Section 209 of the Hawaii Standard Specifications for Road and Bridge Construction dated 2005 and applicable Special Provisions. A list of pollutant sources and corresponding BMP used to mitigate the pollutants are included in Section 209 of the Special Provisions under Appendix A.

Follow the requirements below:

1. Protect all Drainage Inlets receiving runoff from disturbed areas (SC-1).
2. Contain on-site runoff using Perimeter Sediment Controls
 - a. SC-2 Vegetated Filter Strips and Buffers
 - b. SC-6 Compost Filter Berm/Sock
 - c. SC-7 Silt Fence or Filter Fabric Fence
 - d. SC-8 Sandbag Barrier
 - e. SC-9 Brush or Rock Filter
3. Control offsite runoff from entering construction area
 - a. EC-3 Run-On Diversion
 - b. EC-6 Level Spreader
 - c. EC-11 Geotextiles and Mats
 - d. EC-12 Seeding and Planting

4. Incorporate applicable Site Management BMP
 - a. SM-1 Construction BMP Training
 - b. SM-2 Material Storage and Handling
 - c. SM-3 Stockpile Management
 - d. SM-4 Concrete Waste and Wash Management
 - e. SM-5 Asphalt Cement Waste Management
 - f. SM-6 Solid Waste Management
 - g. SM-7 Sanitary Waste Management
 - h. SM-9 Hazardous Materials and Waste Management
 - i. SM-10 Spill Prevention and Control
 - j. SM-11 Vehicle and Equipment Cleaning
 - k. SM-12 Vehicle and Equipment Maintenance
 - l. SM-13 Vehicle and Equipment Refueling
 - m. SM-14 Scheduling
 - n. SM-15 Location of Potential Sources of Sediment
 - o. SM-16 Staging Area
 - p. SM-17 Preservation of Existing Vegetation
 - q. SM-19 Dust Control
 - r. SM-20 Paving Operations
5. Contain pollutants within the Construction Staging/Storage Area BMP with applicable Perimeter Sediment Controls and Site Management BMP. Include a Stabilized Construction Entrance/Exit (SC-11) for all areas which exit onto a paved street. Restrict vehicle access to these points.
6. Manage Concrete Waste including installing a Concrete Washout Area (SM-4) and properly disposing of Concrete Curing Water (California Stormwater BMP Handbook NS-12 Concrete Curing).
7. Remove saw cut slurry and hydrodemolition water from the site by vacuuming. Provide storm drain protection and/or perimeter sediment controls during saw cutting and hydrodemolition work.

DATE	BY	REVISION

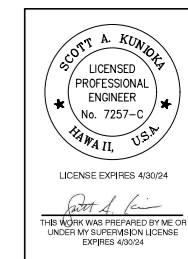

STATE OF HAWAII
DEPARTMENT OF TRANSPORTATION
HIGHWAYS DIVISION

**WATER POLLUTION AND
EROSION CONTROL NOTES**

**TEMPORARY KAPAA BYPASS
ROAD REPAIR
Vicinity of Oloheua Road
Project No. 5600-02-23M**


Scale: None Date: December, 2023

SHEET No. EC-3A OF 5 SHEETS

DATE	REVISION
02/09/24	△ - Revised Permit Requirement Notes

FED. ROAD DIST. NO.	STATE	PROJ. NO.	FISCAL YEAR	SHEET NO.	TOTAL SHEETS
HAWAII	HAW.	5600-02-23M	2024	ADD14	21


TRUE NORTH
SCALE: 1" = 10'

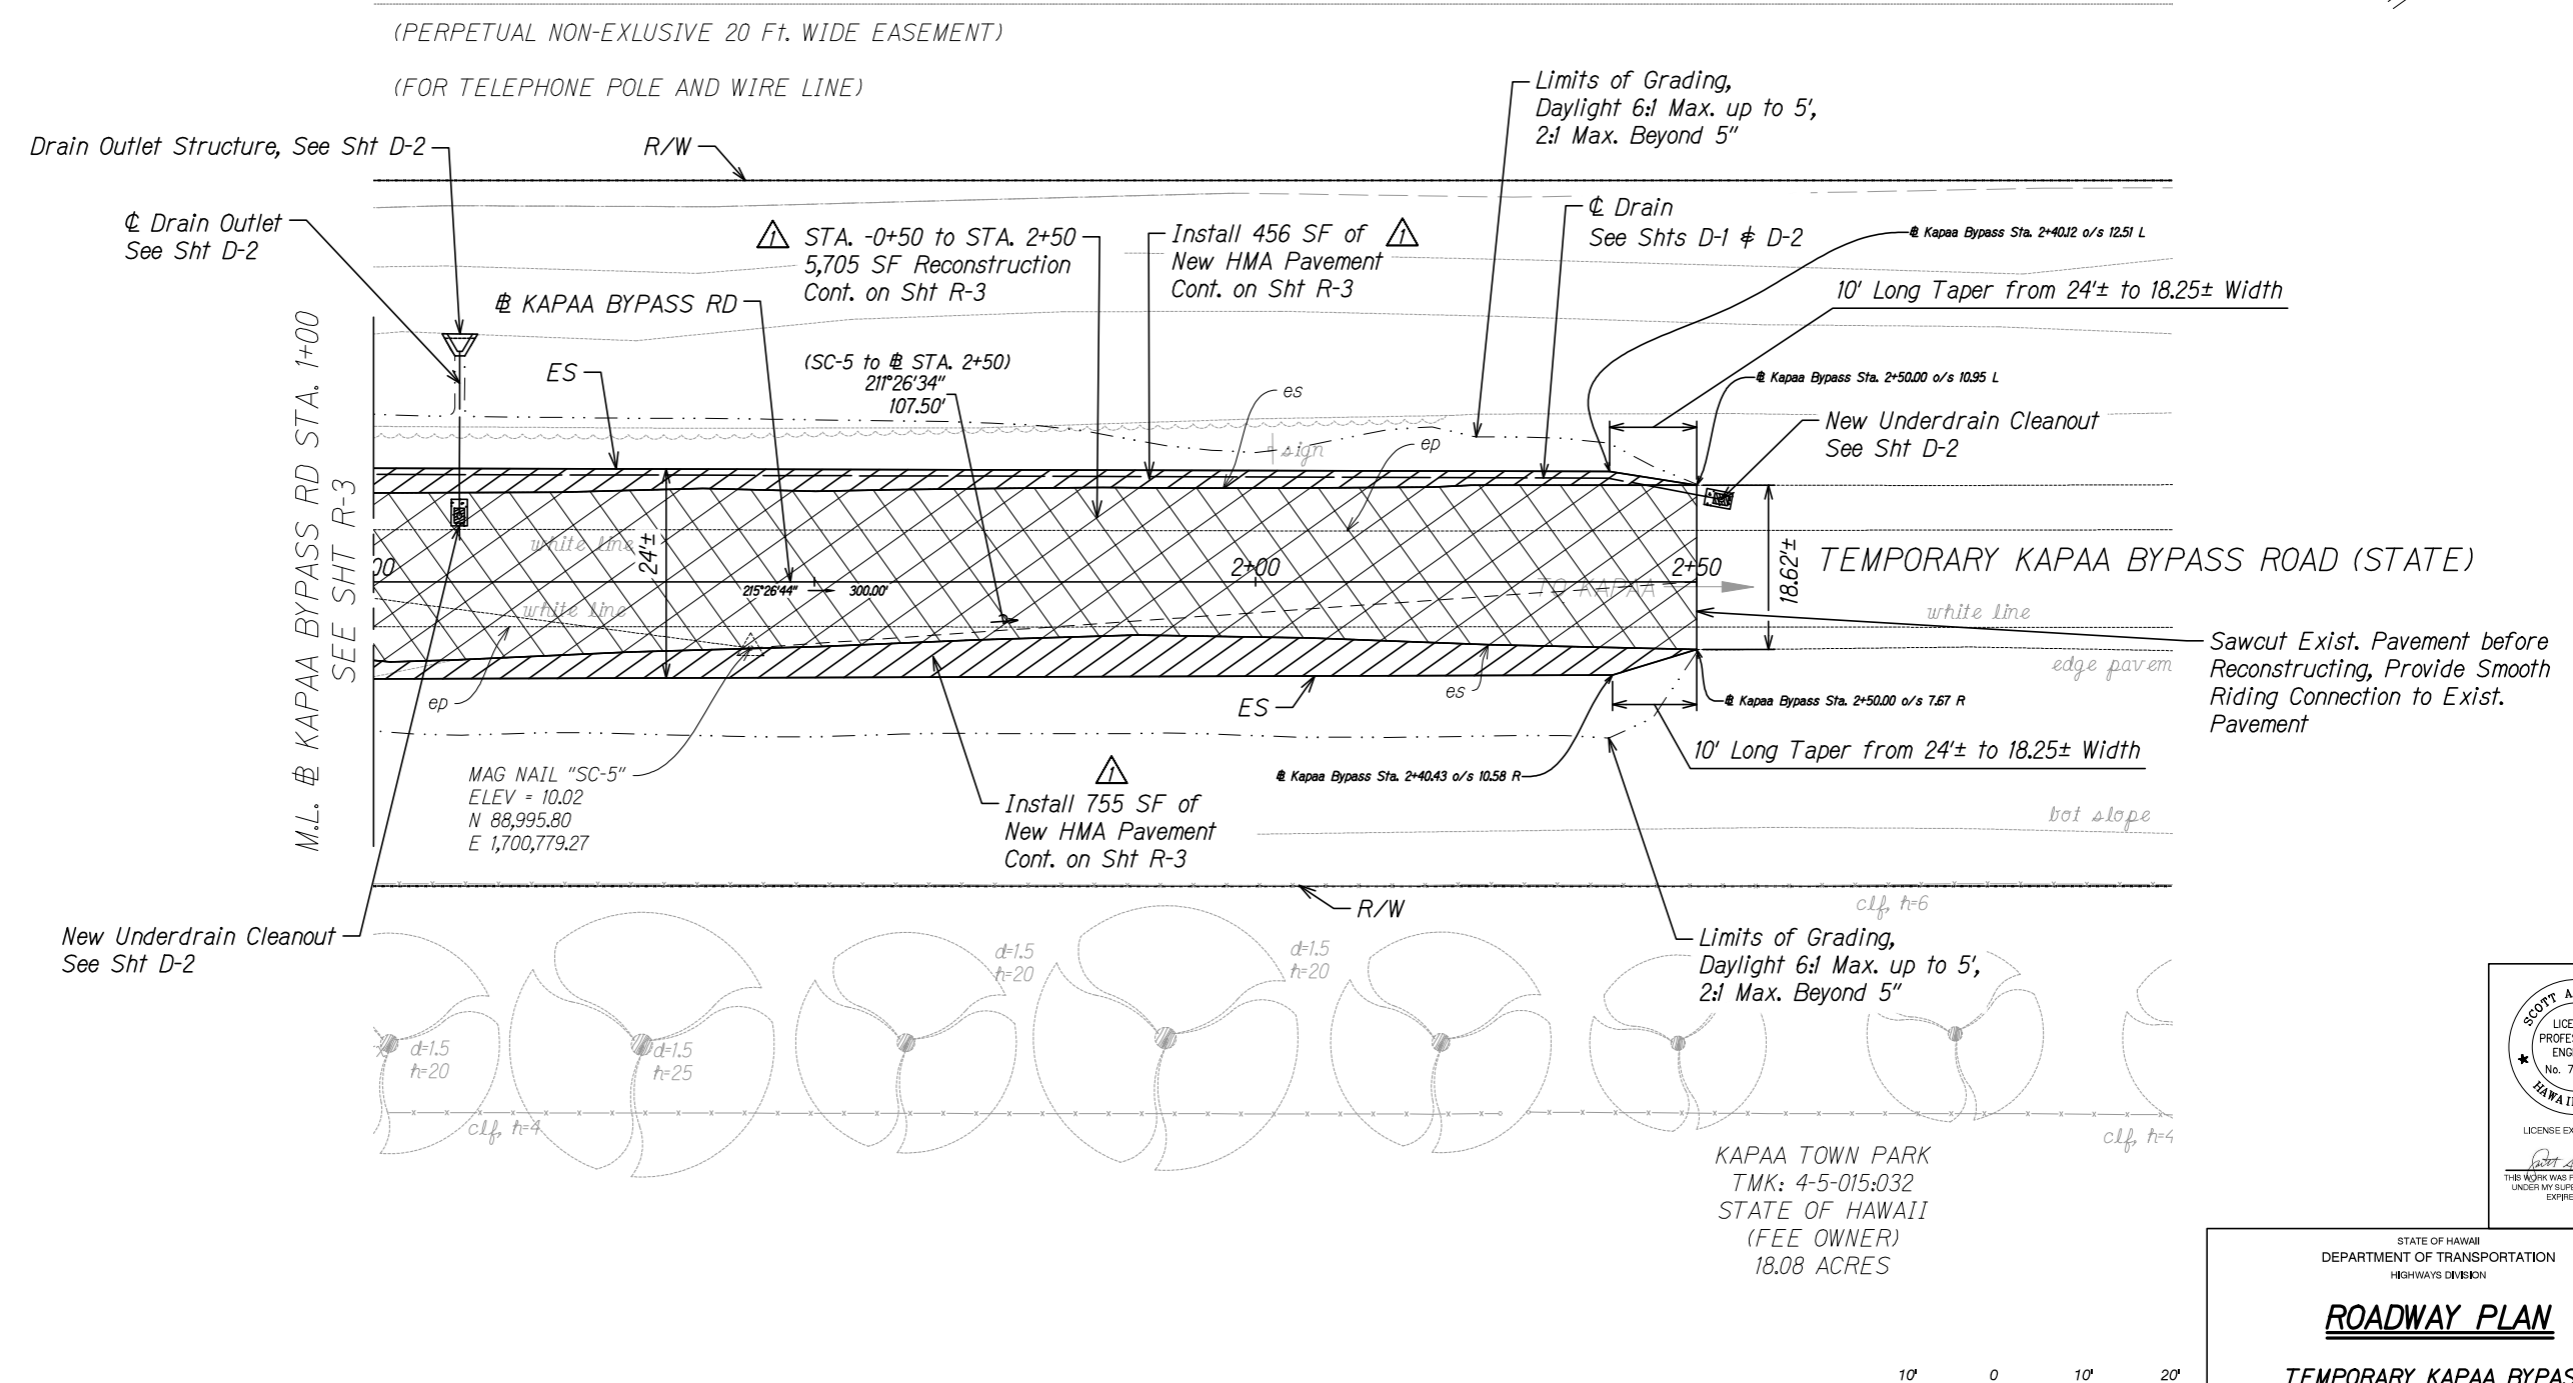

DATE	BY	REVISION



ROADWAY PLAN
STA. 1+00 TO 2+50
Scale: 1"=10'

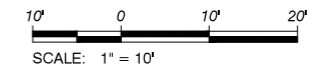

DATE	REVISION
02/09/24	△ - Revised Pavement Callouts

STATE OF HAWAII
DEPARTMENT OF TRANSPORTATION
HIGHWAYS DIVISION

ROADWAY PLAN

TEMPORARY KAPAA BYPASS ROAD REPAIR
Vicinity of Oloheua Road
Project No. 5600-02-23M

Scale: 1"=10' Date: December, 2023

SHEET No. R-4A OF 6 SHEETS

MINUTES OF THE PRE-BID MEETING

PROJECT: Temporary Kapaa Bypass Road Repair, Vicinity of Olohena Road

FED-AID PROJ. NO.: 5600-02-23M

LOCATION: Microsoft Teams Video Conference

DATE & TIME: January 25, 2024 at 10:00 A.M.

IN ATTENDANCE:

Eric Fujikawa	HDOT – HWY-K
Scott Kunioka	Akinaka and Associates, Ltd.
Ryden Quitoriano	Akinaka and Associates, Ltd.
Taylor Byington	WW Clyde
Garett Ichimura	Koga Engineering & Construction, Inc.
Alyssa Carveiro	Earthworks Pacific, Inc.
Scott Smith	Cushnie Construction Company, Inc.

The meeting started at 10:00 A.M. Eric Fujikawa began the meeting with an introduction and overview of the project’s scope of work.

Anything said at this meeting is for clarification purposes only, the bid documents shall govern over anything said today and discrepancies shall be clarified via addendum.

All questions resulting from this meeting were directed to be submitted through HIePRO and will be answered through an addendum.

The HIePRO contract start date of 5/1/24 is an estimate only and the official notice to proceed will be issued by HDOT in accordance with the contract specifications.

The following question was raised at the meeting:

There were no questions

With no questions or comments, the pre-bid meeting was adjourned at 10:07 A.M.

The minutes of the meeting will be distributed in Addendum No. 1 of the Contract Plans. Contractors will be notified via HIePRO when the addendum will be available.

Responses to Request for Information (RFI's/Questions)
HIePRO Questions for solicitation B24001353
Temporary Kapaa Bypass Road Repair, Vicinity of Olohena Road
Project No. 5600-02-23M
As of February 2, 2024

1. Will the project contract be administered by an outside construction manager? If so, which firm?

RESPONSE: The project is expected to be managed by a construction management company. The firm is not identified at this time.

2. Sheet # EC-3 of 5 Sheets- Sheet #8. Permit Requirements: states that the calculated land disturbance is 34.43acres. Please confirm if this project falls under an NPDES Permit?

RESPONSE: See Addendum No. 1 for updated Sheet 8

3. Is there an attendees list from the pre-bid meeting?

RESPONSE: See pre-bid meeting minutes in Addendum No. 1

4. Please confirm if the contract duration is from 05/01/2024 to 05/31/2024 as stated in the General Information of the HIePRO webpage or 70 working days as stated on P-1 of the Proposal.

RESPONSE: The May 1, 2024 start date is an estimate only and the official notice to proceed will be issued by HDOT in accordance with the contract specifications. The 70 working days as stated on P-1 of the Proposal will be the length of the contract.